


DEMOLITION NOTES:

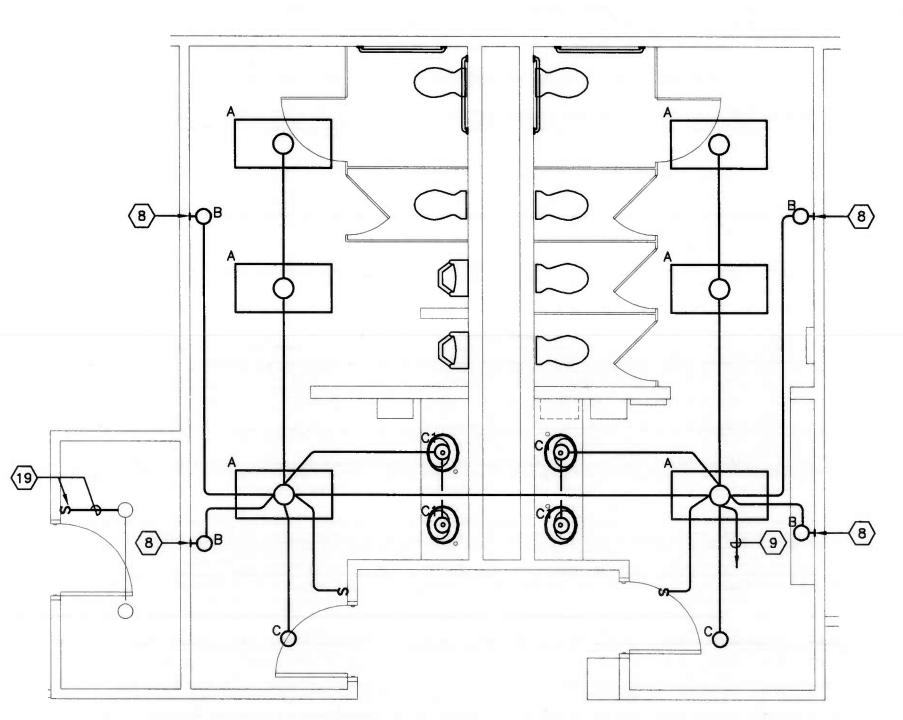

FLOOR PLAN - DEMOLITION - ELECTRICAL

THE OWNER SHALL HAVE THE RIGHT OF FIRST

MATERIAL THAT IS REMOVED AND NOT CLAIMED

BY THE OWNER SHALL BECOME THE PROPERTY

OF THE CONTRACTOR WHO SHALL DISPOSE OF

BRANCH CIRCUITS THAT ARE BROKEN BY THE REMOVAL OF DEVICES SHALL BE REPAIRED AND RETURNED TO AN OPERABLE CONDITION.

REFUSAL ON MATERIAL THAT IS REMOVED.

FLOOR PLAN - NEW WORK - LIGHTING

ELECTRICAL LEGEND

NOTES: 1. MOUNTING HEIGHTS SHALL BE TO THE CENTER OF THE DEVICE ABOVE FINISHED FLOOR UNLESS OTHERWISE NOTED.

LIGHTING FIXTURE - 2'X4' FLUORESCENT FIXTURE TYPE AS SPECIFIED

LIGHTING FIXTURE - RECESSED OR SURFACE MOUNTED - TYPE AS SPECIFIED EMERGENCY LIGHT - TYPE AS SPECIFIED

JUNCTION BOX FLUSH OR SURFACE MOUNTED ON WALL

WIRING IN OR ON CEILINGS AND WALLS. FOR BRANCH CIRCUITS, HASH MARKS INDICATE THE NUMBER OF CONDUCTORS IF MORE THAN THE DEFAULT OF 2 PLUS GROUND. SEE PANELBOARD SCHEDULE FOR WIRING METHOD, SIZES OF CONDUCTORS AND SIZES OF CONDUIT WHERE APPLICABLE.

HOMERUN TO PANEL. HASH MARKS INDICATE THE NUMBER OF CONDUCTORS IF MORE THAN THE DEFAULT OF 2 PLUS GROUND. SEE PANELBOARD SCHEDULE FOR WIRING SIZES AND NUMBER OF CONDUCTORS.

SINGLE POLE SWITCH - M.H. 48" A.F.F. MANUAL MOTOR STARTER WITH THERMAL OVERLOADS - M.H. 48" A.F.F.

DUPLEX RECEPTACLE - NEMA 5-20R CONFIGURATION -M.H. 18" A.F.F.

DOUBLE DUPLEX RECEPTACLE - NEMA CONFIGURATION - 5-20R - M.H. 18" A.F.F.

DUPLEX RECEPTACLE - 5-20R NEMA CONFIGURATION GROUND FAULT INTERRUPT - M.H. 18" A.F.F

DIAGONAL LINE DENOTES RECEPTACLE MOUNTED AT 42" A.F.F. OR 8" ABOVE COUNTER MOTOR - HORSEPOWER INDICATED WHERE APPLICABLE

SAFETY DISCONNECT OR SWITCH.

PANELBOARD - SURFACEMOUNTED. RECESSED MOUNTED - M.H. 6'-6" TO TOP

FIRE ALARM VISUAL APPLIANCE. SUBSCRIPT DENOTES CANDELLA RATING. M.H. 80" A.F.F. TO BOTTOM OF LENS.

SPECIFIC NOTE - REFER TO SPECIFIC NOTES

REVISION NOTE - REFER TO REVISION BLOCK

ELECTRICAL ABBREVIATIONS

ABBREVIATIONS. DESCRIPTION

AMPERE ABOVE FINISHED FLOOR AMPS INTERRUPTING CURRENT AMERICAN WIRE GAUGE CONDUIT EXHAUST FAN ELECTRIC METALIC TUBING EMT FLA G OR GRD FULL LOAD AMPS GROUND GROUND FAULT INTERRUPTER HORSEPOWER KILOVOLTS KILO-VOLT-AMPERE KILOWATTS LIGHTING MCB MAIN CIRCUIT BREAKER MOUNTING HEIGHT MAIN LUGS ONLY NATIONAL ELECTRIC CODE NIGHT LIGHT POLE PHASE

RUN LOAD AMPS

WATER HEATER

WEATHER-PROOF

UNDERWRITERS LAB

ROOM

VOLTS

WATTS

DISCONNECT AND REMOVE EXISTING LIGHTING FIXTURE, SWITCHES AND ASSOCIATED BRANCH CIRCUITING. EXISTING LIGHTING BRANCH CIRCUIT SHALL REMAIN FOR REUSE.

SPECIFIC NOTES (APPLY TO DRAWING E101 WHERE INDICATED):

- (2) DISCONNECT AND REMOVE EXISTING ELECTRIC HAND DRYER, AND ASSOCIATED BRANCH CIRCUIT.
- DISCONNECT AND REMOVE EXISTING RECEPTACLE. EXISTING RECEPTACLE BRANCH CIRCUIT SHALL REMAIN FOR REUSE.
- DISCONNECT AND REMOVE EXISTING FIRE ALARM SYSTEM DEVICE AND SAVE FOR REUSE. EXISTING FIRE ALARM SYSTEM CIRCUIT SHALL REMAIN FOR REUSE. DISCONNECT AND REMOVE EXISTING CEILING SPEAKER. SPEAKER AND SPEAKER SYSTEM WIRING
- SHALL BE SAVED FOR REUSE. (6) DISCONNECT AND REMOVE EXISTING LIGHTING FIXTURE AND ASSOCIATED BRANCH CIRCUITING.
- DISCONNECT AND REMOVE EXISTING VENDING MACHINE RECEPTACLES. EXISTING BRANCH CIRCUITS
- SHALL REMAIN FOR REFEED OF RELOCATED VENDING MACHINES. (8) CONNECT EMERGENCY BATTERY UNIT TO UNSWITCHED PORTION OF LIGHTING BRANCH CIRCUITS.
- (9) EXTEND AND CONNECT 2#12, 1#12GRD., 3/4"C. TO BRANCH CIRCUIT THAT PREVIOUSLY FED
- RELOCATE FIRE ALARM DEVICES SAVED FOR REUSE AND CONNECT TO EXISTING FIRE ALARM CIRCUIT THAT PREVIOUSLY FED THIS AREA.
- EXTEND AND CONNECT 2#12, 1#12 GRD., 3/4"C. TO EXISTING BRANCH CIRCUIT THAT PREVIOUSLY FED RECEPTACLES IN THIS AREA.
- PROVIDE 20 AMP, 277 VOLT, DOUBLE POLE, SINGLE THROW SWITCH 6" BELOW CEILING TO ACT AS DISCONNECT FOR HAND DRYER. PROVIDE PLASTIC LAMINATE NAME PLATE TO READ "HAND DRYER DISCONNECT". PROVIDE NEW 20 AMP, 2 POLE CIRCUIT BREAKER IN EXISTING PANEL BOARD 'K1A' IN ADJACENT ROOM (PLAN LEFT). EXTEND AND CONNECT 2#12, 1#12 GRD., 3/4"C. (APPROXIMATELY 60'-0") TO NEW 20 AMP, 2 POLE CIRCUIT BREAKER IN PANEL" 'K1A'."
- TRANSFORMER FOR AUTOMATIC FLUSH VALVES, FURNISHED UNDER DIVISION 15 AND CONNECTED UNDER DIVISION 16. PROVIDE NEW 20 AMP, 1 POLE CIRCUIT CIRCUIT BREAKER IN EXISTING PANEL BOARD 'K1A' IN ADJACENT ROOM (PLAN LEFT). EXTEND AND CONNECT 2#12, 1#12 GRD., 3/4C"C. (APPROXIMATELY 60'-0") TO NEW 20 AMP, 1 POLE IN EXISTING PANEL 'K1A'.
- JUNCTION BOX FOR LOW VOLTAGE CONNECTION TO AUTOMATIC VALVE, COORDINATE FINAL LOCATION PER VALVE INSTALLERS DIRECTION.
- RECONNECT VENDING MACHINE RECEPTACLES TO BRANCH CIRCUITS THAT PREVIOUSLY FED VENDING MACHINES (REFER TO NOTE 7).
- DISCONNECT AND REMOVE EXISTING MICROWAVE RECEPTACLE. EXISTING BRANCH CIRCUIT SHALL
- REMAIN FOR REFEED OF RELOCATED MICROWAVE.
- RECONNECT MICROWAVE OVEN TO BRANCH CIRCUIT THAT PREVIOUSLY FED MICROWAVE (REFER TO NOTE 16). (18) DISCONNECT AND REMOVE EXISTING LIGHT SWITCH.
- (19) PROVIDE NEW LIGHT SWITCH AND TIE INTO EXISTING STORAGE ROOM LIGHTING FIXTURES.

LIGHTING IN THIS AREA.

- PROVIDE 20 AMP, 1 POLE CIRCUIT BREAKER IN EXISTING PANEL BOARD 'K1A' IN ROOM
- ADJACENT TO MENS ROOM (PLAN LEFT). EXTEND AND CONNECT 2#12, 1#12 GRD., 3/4"C. (APPROXIMATELY 170'-0") TO NEW 20 AMP, 1 POLE CIRCUIT BREAKER IN EXISTING PANEL 'K1A'.
- 20 RECONNECT SPEAKERS SAVED FOR REUSE TO EXISTING SOUND SYSTEM.

GANT HART BRUNNETT ARCHITECTS 15 West Mulberry Street Baltimore, Maryland 21201-4406

Telephone Number: 410-234-8444

THESE DOCUMENTS HAVE BEEN PREPARED FOR THE PROJECT NAMED. THEY ARE NOT TO BE USED WITH ANY OTHER PROJECTS WITHOUT THE APPROVAL AND PARTICIPATION OF GANT HART BRUNNETT ARCHITECTS. REPRODUCTION IS PROHIBITED

(C) GANT HART BRUNNETT ARCHITECTS **CONSULTANTS:**



S C H L E N G E R / P I T Z & ASSOCIATES, INC. Consulting Engineers 5 West Aylesbury Road, imonium, Maryland 21093 Phone 410.561.1337

Fax 410.561.1446 www.spaengineers.com © Copyright 2002

PROJECT:

POINT ROAD 21222 BATHROOM REMODEL 200 SOLLERS POINT RO - DUNDALK BALTIMORE,

PROJ. NO: 20219 DATE: 08/25/04 SCALE: AS NOTED REVISION: PERMIT/BID 8/25/04

FLOOR PLANS, LEGEND, **ABBREVIATIONS** AND SCHEDULES


SHEET NO. 1 OF 2

ADF/MEH MEW 04166A

NOTE: VERIFY CEILING AND WALL CONSTRUCTION AND FINISHES WITH THE ARCHITECT'S DRAWINGS AND FINISH SCHEDULES FURNISH PROPER INDICATED ARE TO BOTTOM OF FIXTURE MANU. / MODEL No. VOLTS NO. 2X4 FLUORESCENT LAY IN WITH DIE FORMED CEILING LIGHTOLIER STEEL HOUSING, BAKED ON WHITE ENAMEL 120/277 'DPA2G' SERIES RECESSED FINISH, 3" DEEP ALUMINUM PARABOLIC LOUVER AND ELECTRONIC BALLAST. EMERGENCY BATTERY UNIT WITH DIE CAS UNIVERSAL LITHONIA 6W XENON ALUMINUM HOUSING, BAKED ON WHITE 120/277 SURFACE (WITH UNIT) 'AFFINITY' SERIES CALCIUM BATTERY AND BUILT IN CHARGER. LIGHTOLIER CEILING WITH 6 3/4" DIA. SPECULAR CLEAR ALZAK 120/277 TRIPLE TUBE RECESSED 'LYTECASTER' SERIES ALUMINUM REFLECTOR AND ELECTRONIC BALLAST.

COMPACT FLUORESCENT DOWNLIGHT CEILING LIGHTOLIER WITH 5" DIA, MATTE BLACK STEP BAFFLE QUAD RECESSED 'LYTECASTER' SERIES REFLECTOR AND ELECTRONIC BALLAST.

LIGHTING FIXTURE SCHEDULE

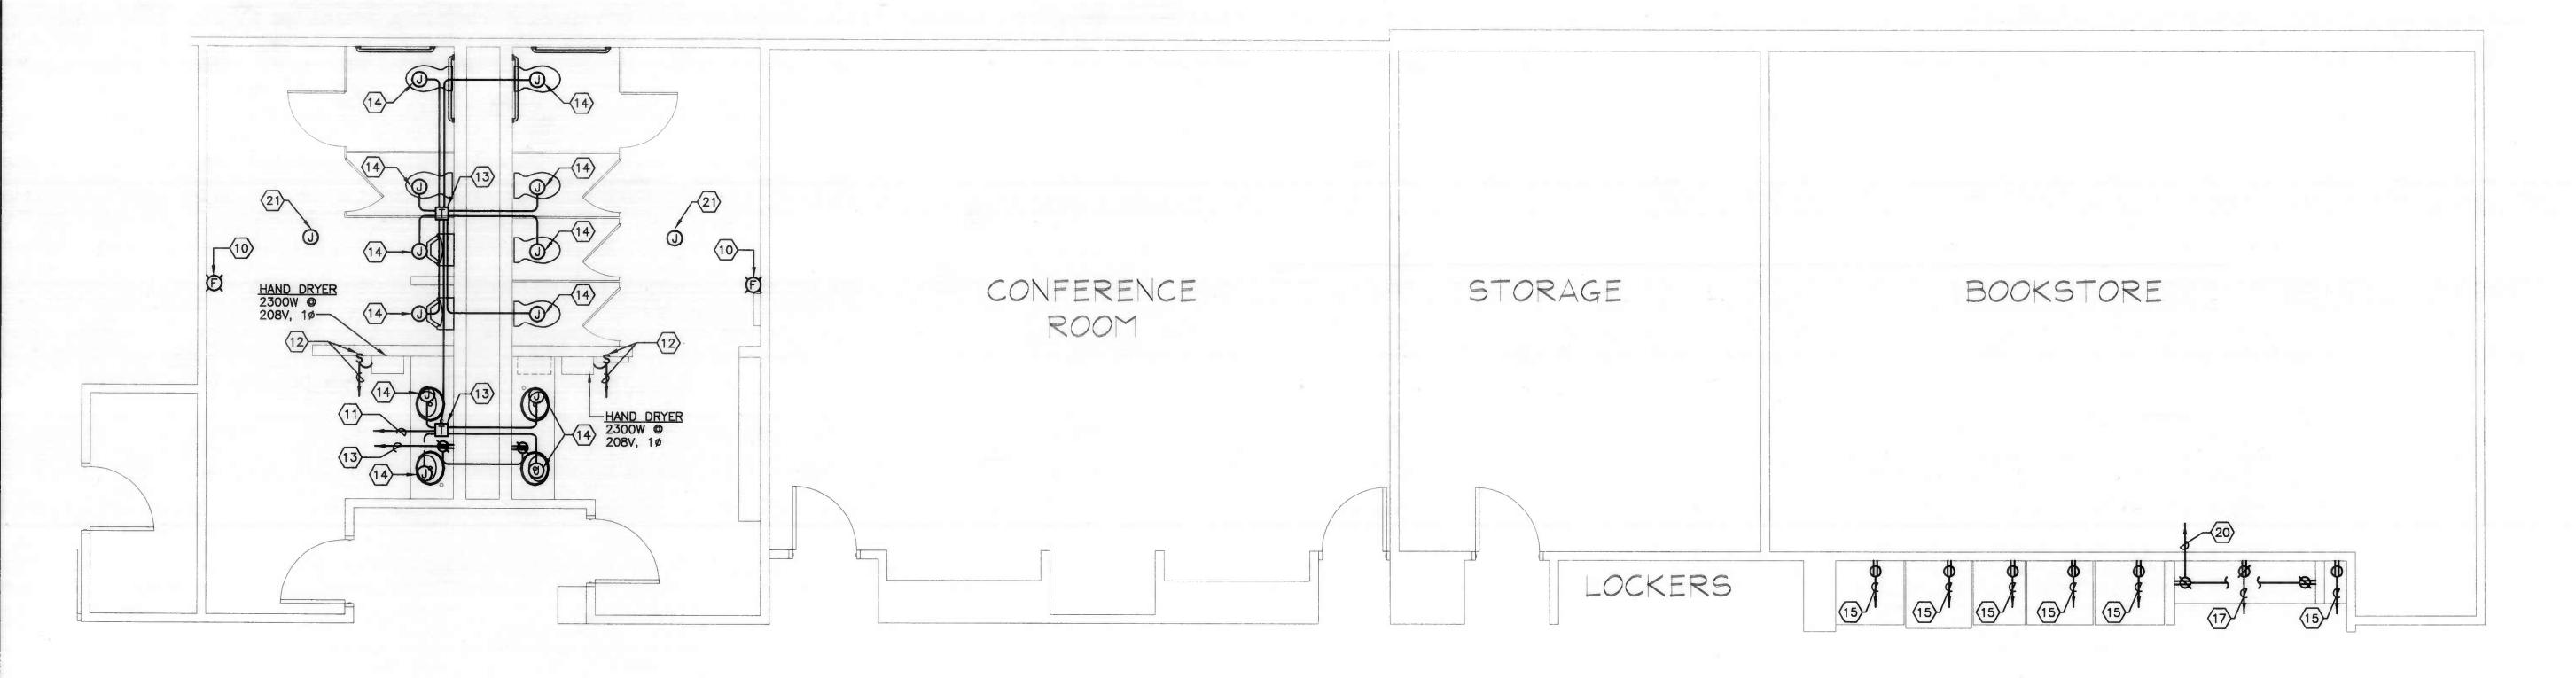

FLOOR PLAN - NEW WORK - POWER

SCALE: 1/4" = 1'-0"

ELECTRICAL DRAWING LIST: E101 FLOOR PLANS, LEGEND, ABBREVIATIONS AND SCHEDULES E102 SPECIFICATIONS

GRAPHIC SCALE

1/16" = 1'-0"

GRAPHIC SCALE 1/4" = 1-0"